

VICINITY MAP
FOR REFERENCE ONLY

Legal Description:
DIAMOND PARK ESTATES
BLK 1 LT 4

SITE PLAN INFORMATION	
LOT SIZE	5,662 SF
TOTAL BUILDING AREA	2,670 SF
PERCENT LOT COVERED	47 %

SQUARE FOOTAGE	
PROPOSED LIVING AREA	2,015 SF
PROPOSED GARAGE	371 SF
PROPOSED COV 'D PATIO	215 SF
PROPOSED PORCH/ENTRY	69 SF
TOTAL	2,670 SF

PROVIDE BASIC CONSTRUCTION INFORMATION
BUILD HIS STRUCTURE. HESE PLANS MUST BE
BUILDER, HOMEOWNER, AND ALL CONTRACTORS OF
ON. BUILDER SHOULD OBTAIN COMPLETE ENGINEERING
AAL BEFORE BEGINNING CONSTRUCTION OF ANY KIND.
D. LOCAL CODES AND RESTRICTIONS TAKE PRECEDENCY
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Lot 4 Block 1 St George Court NRH, TX 76182


SITE PLAN

Date 4/28/2020	Drawn By ER
Scale	North
1'-0"=20'-00"	

Sheet

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SITE PLAN 1 | 1

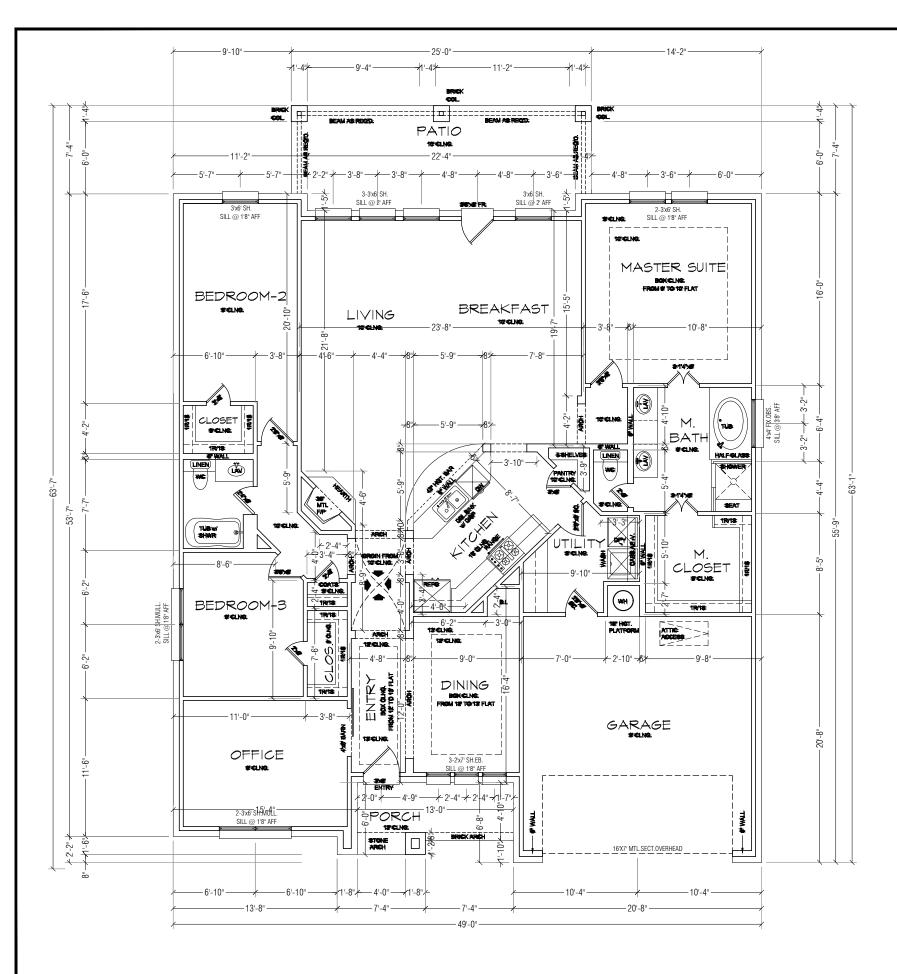

FLOOR PLAN

scale: 1/8"=1'-0"

	KEY
TAG	DESCRIPTION
SH	SINGLE HUNG WINDOW
HC	HOLLOW CORE DOOR
SC	SOLID CORE DOOR
SD	SLIDING DOOR
FX	FIXED WINDOW
DB	DOUBLE DOOR
GD	GLASS DOOR
FD	FRENCH PATIO DOOR
BID	BI-FOLD DOOR

- ALL STRUCTURAL INFORMATION SHOWN FOR REFERENCE PURPOSES ONLY. CONTRACTOR SHALL HAVE LICENSED STRUCTURAL ENGINEER REVIEW AND DESIGN ALL STRUCTURAL ELEMENTS SUCH AS ALL FRAMING
- ALL DIMENSIONS ARE FROM FACE OF STUD TO FACE OF STUDS UNLESS NOTED OTHERWISE.
- WINDOW SIZES INDICATED ON PLANS ARE NOTED BY APPROXIMATE ROUGH OPENING SIZE, REFER TO PLANS AND EXTERIOR ELEVATIONS FOR WINDOW
- COORDINATE LOCATION OF UTILITY METERS WITH SITE PLAN AND LOCATE AWAY FROM PUBLIC VIEW. VISUAL IMPACT SHALL BE MINIMIZED, I.E. MOUNT AS LOW AS POSSIBLE.
- CONTRACTOR SHALL COORDINATE ALL CLOSET SHELVING REQUIREMENTS DO NOT SCALE DRAWINGS, FOLLOW DIMENSIONS ONLY.
- CONTRACTOR SHALL FIELD VERIFY ALL CABINET DIMENSIONS BEFORE
- BEDROOM WINDOWS SHALL HAVE A MINIMUM NET CLEAR OPENING OF 5. SQ.FT. A MINIMUM NET CLEAR OPENABLE WIDTH OF 20", A MINIMUM NET CLEAR OPENABLE HEIGHT OF 24" AND HAVE A MAXIMUM FINISH SILL
- ALL GLASS LOCATED WITHIN 18" OF FLOOR, 12" OF A DOOR OR LOCATED WITHIN 60" OF FLOOR AT BATHTUBS, WHIRLPOOLS, SHOWERS, SAUNAS, STEAM ROOMS OR HOT TUBS SHALL BE TEMPERED.
- PROVIDE COMBUSTION AIR VENTS, WITH SCREEN AND BACK DAMPER, FOR FIREPLACES, WOOD STOVES AND ANY APPLIANCE WITH AN OPEN FLAME.
- WITH A MINIMUM OF A 90 CFM FAN. RANGE HOODS SHALL ALSO BE VENTED TO OUTSIDE.
- ATTIC HVAC UNITS SHALL BE LOCATED WITHIN 20' OF ITS SERVICE OPENING. RETURN AIR GRILLES SHALL NOT BE LOCATED WITHIN 10 FEET OF A GAS FIRED APPLIANCE.
- ALL FIREPLACE CHASE WALLS SHALL BE INSULATED INSIDE AND OUTSIDE. PROVIDE HORIZONTAL 'DRAFT STOPS' AT EACH FLOOR LEVEL BY PACKING
- ALL INTERIOR WALLS SHALL BE COVERED WITH 1/2" GYPSUM BOARD, WITH METAL CORNER REINFORCING. TAPE FLOAT AND SAND. (3 COATS) USE 5/8" GYPSUM BOARD ON CEILING WHEN SUPPORTING MEMBERS ARE 24" O.C. OR GREATER USE 1/2" GYP. BOARD ON CEILING MEMBERS LESS THAN 24" O.C.
- ALL BATH AND TOILET AREA WALLS AND CEILINGS SHALL HAVE WATER

SQUARE FOOTAGE	
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- ALL CEILINGS TO BE 8'-0" FOR FIRST STORY UNLESS NOTED.
- BUILDER TO APPROVE & VERIFY ALL PLANS BEFORE CONSTRUCTION.
- VERIFY ALL PLANS W/ LOCAL BUILDING CODES.
- HVAC TO BE IN ATTIC UNLESS OTHERWISE NOTED.
- W.H. IN UTILITY CLOSET.
- PROVIDE SHUT-OFF VALVE FOR ALL GAS APPLIANCES REFERENCE IRC SECTION G2419.
- ALL GLASS LOCATED WITHIN 18" OF FLOOR, 12" OF A DOOR OR LOCATED WITHIN 60" OF FLOOR AT BATHTUBS, WHIRLPOOLS, SHOWERS, SAUNAS, STEAM ROOM OR HOT TUBS SHALL BE TEMPERED. TO COMELY W/ IRC SECTION R308.4.8


- WALLS, BEAMS, CONNECTION. HEADERS, JOIST AND RAFTERS.

- FABRICATION
- HEIGHT OF 43" FROM FINISH FLOOR.
- ALL EXPOSED INSULATION SHALL HAVE A FLAME SPREAD RATING OF LESS THAN 25 AND A SMOKE DENSITY RATING OF LESS THAN 450.
- BATHROOMS AND UTILITY ROOMS SHALL BE VENTED TO THE OUTSIDE
- ALL WALLS AND CEILINGS IN GARAGE AND GARAGE STORAGE AREAS TO HAVE 5/8" TYPE-X GYP. BOARD W/ 1-HOUR FIRE RATING. ALL EXT. DOORS IN GARAGE TO BE METAL OR SOLID CORE DOORS INCLUDING DOORS ENTERING HEAT/COOLED PORTION OF RESIDENCE.
- 6" (R-19) INSULATION BETWEEN 2x4 JOISTS.
- RESISTANT GYPSUM BOARD.

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FLOOR PLAN

	Date 4/28/2020	Drawn By ER
	Scale 1/8" 1'-0"	North

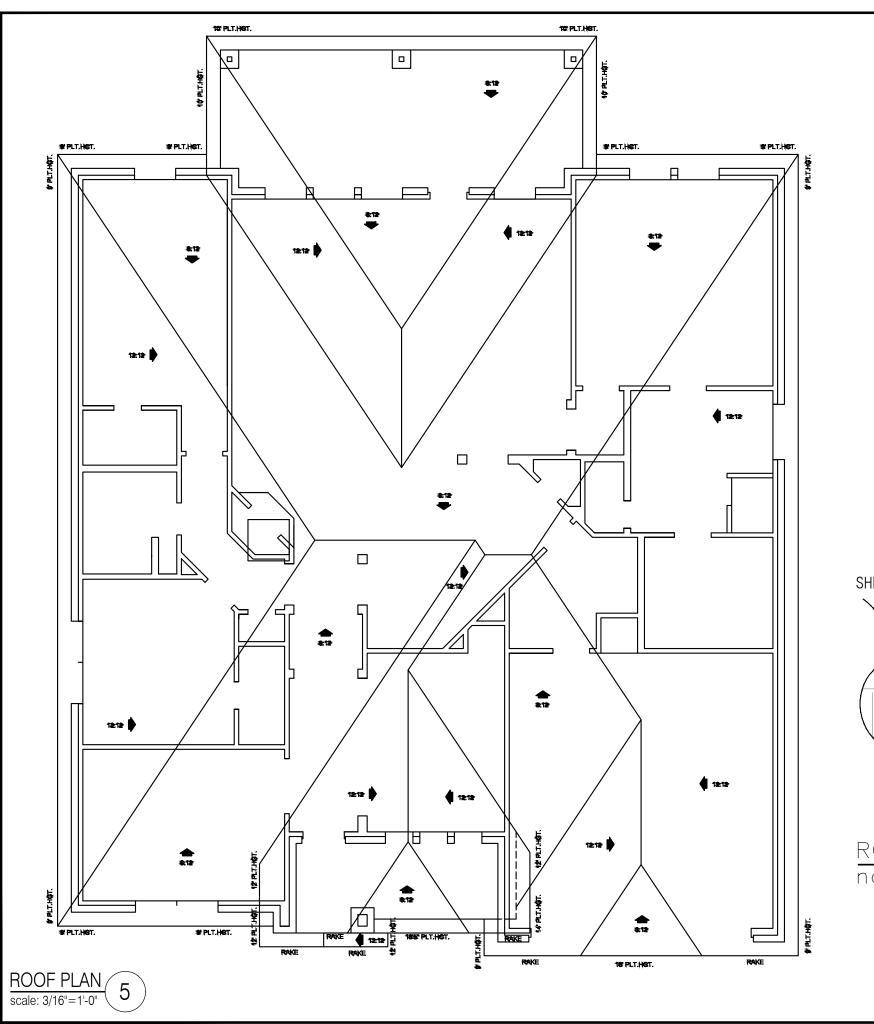

NOTE:


- 1. MAIN ROOF PITCH TO BE 8:12 UNLESS NOTED.
- MAIN PLATE LINE TO BE 9'-0" UNLESS NOTED.
 ROOF ADDITION TO BE COMPOSITION SHINGLES, THAT WILL MATCH EXISTING UNLESS NOTED.

FRAMING NOTES:

- 1. RAFTERS TO BE SUPPORTED BY CONT BRACING FOR HORIZONTAL SPANS OF 15'-0" OR GREATER.
- 2. SUPPORT ALL HIP, VALLEYS AND RIDGES @ 8'-0" O.C. MAX.
- 3. ALL RAFTERS TO BEAR ON SECOND FLOOR WALLS WHERE APPLICABLE.
- RAFTERS MAY BE SPLICED ONLY @ CONT. BRACING OR SECOND FLOOR WALLS.
- i. RAFTERS TO BE PLACED IN COMPLIANCE WITH ALL LOCAL CODES

EXAMPLE:


- A- 2x6 RAFTERS @ 16" O.C. MAX. WITH 1/2" P.W. DECKING.
- 3- 2x6 RAFTERS @ 24" O.C. MAX. WITH 5/8" P.W. DECKING.
- C- 2x8 RAFTERS @ 24" O.C. MAX. WITH 5/8" P.W. DECKING.
- 6. FASCIA OVERHANG TO BE 18" (TYP.)
 UNLESS NOTED ON ELEVATIONS.
- '. ALL HIP/ VALLEY RAFTERS TO BE 2x8 UNLESS NOTED.

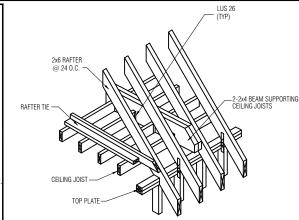

BEAM & RAFTER TIE DETAIL

NOT TO SCALE

2x6 MIN. RAFTERS 2x8 MIN. RIDGE, HIPS, VALLEYS CHECK PLAN FOR SPACING INCREASE ONE SIZE LARGER THAN RAFTER STIFFBACK @ MID SPANS 2x4 MIN COLLAR TIES @ 48" O.C. MAX 2x4 MIN. BRACES @ 48" O.C. MAX. DOUBLE 2x4'S IF OVER 8'-0" 32" O.C. WINDSTORM AREAS 2x12 MIN JOIST FOR 1ST STORY 2x8 MIN JOIST FOR 2ND STORY 2-2x4 TOP PLATES 2x4 STUDS @ 16" O.C. TYPICAL ROOF NOT TO SCALE

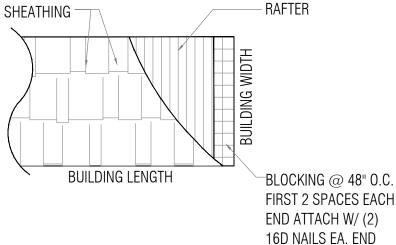

ROOF SHEATHING LAYOUT

not to scale

ROOF VENTING NOTES

PROVIDE ADEQUATE VENTING FOR ATTIC USING A COMBINATION OF CONTINUOUS SOFFIT VENTING AND EITHER CONTINUOUS RIDGE VENTS AT ALL ROOF RIDGES OR VENT TILES TO COORDINATE WITH ROOF TILES. OWNER TO MAKE FINAL DECISION. IF VENT TILES ARE SELECTED, THEY SHALL BE LOCATED ON THE UPPER 1/3 OF THE ROOF AND INSTALLED ON THE ROOF PLANES NOT VISIBLE FROM THE MAIN ENTRY DRIVE. REFER TO ROOF TILE MANUFACTURER SPECIFICATIONS FOR ANY ADDITIONAL VENTING NOTES OR REQUIREMENTS.

ESE PLANS ARE INTENDED TO PROVIDE BASIC CONSTRUCTION INFORMATION INCESSARY TO SUBSTRUCTURE. THESE PLANS MUST BE RIFIED AND CHECKED BY THE BUILDER, HOMEOWNER, AND ALL CONTRACTORS OF SIX OB PRINCIPION. BUILDER SHOULD DBTAIN COMPLETE ENGINEERING FRANCES, HAAC, AND STRUCTURAL BEFORE BEGINNING CONSTRUCTION OF ANY KIND. DTE: ALL FEDERAL, STATE, AND LOCAL CODES AND RESTRICTIONS TAKE PRECEDENCE ANY PART OF THESE PLANS.

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WASTA CARE AND EFFORT HAVE GONE INTO THE CREATION OF THESE BLUEPRINTS. SMACKEN, BECAUSE OF THE VARIANCE IN GEOGRAPHIC LOCATIONS.

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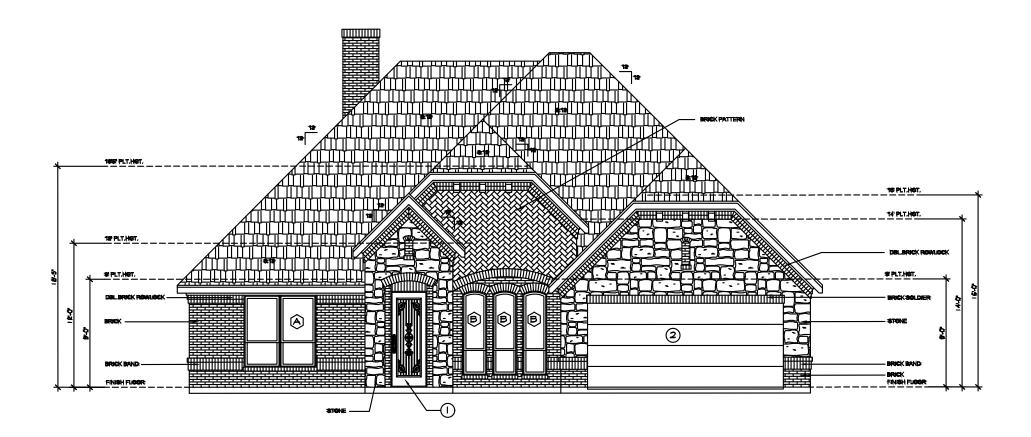
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ROOF PLAN

Date	Drawn By
4/28/2020	ER
Scale	North
3/16" = 1'-0"	


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FRONT ELEVATION

scale: 1/8"=1'-0"



REAR ELEVATION

scale: 1/8"=1'-0"
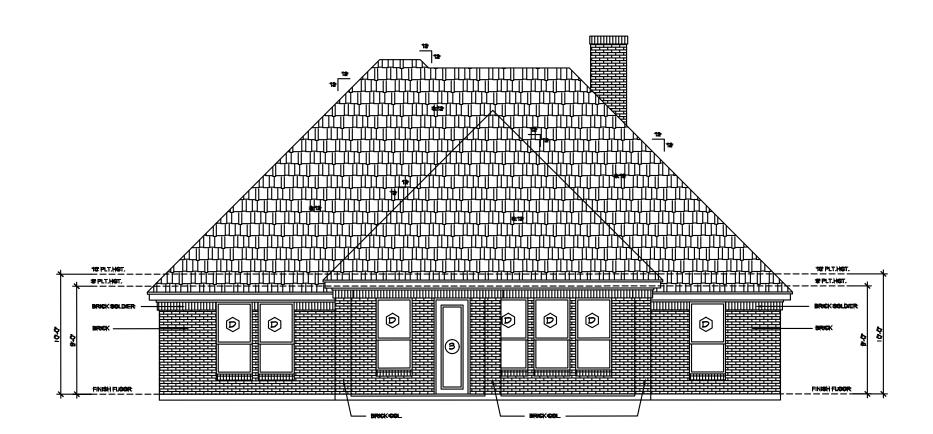
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TIE: ALL FEDERAL, STATE, AND LOCAL CODES AND RESTRICTIONS TAKE PRECEDENCE EER ANY PART OF THESE PLANS.

EER CARE AND EFFORT HAVE GONE INTO THE CREATION OF THESE BLUEPRINTS. MEVER, BECAUSE OF THE VARRANCE IN GEOGRAPHIC LOCATIONS, FUSION DESIGN L. NOT ASSUME LIABILITY FOR ANY DAMAGES DUE TO ERRORS, OMISSIONS, OR EIGNORES, OMISSIONS, OR DESIGNED TO COMMENT OF CONSTRUCTION.

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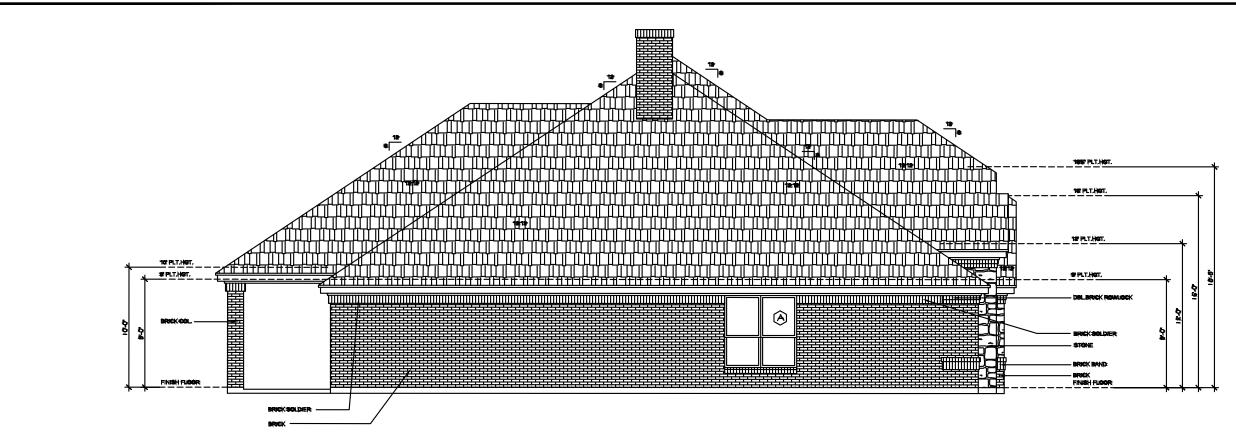
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ELEVATIONS PLAN

Date 4/28/2020	Drawn By ER
Scale	North
1/8"=1'-0"	


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LEFT ELEVATION

scale: 1/8"=1'-0"



RIGHT ELEVATION

scale: 1/8"=1'-0"
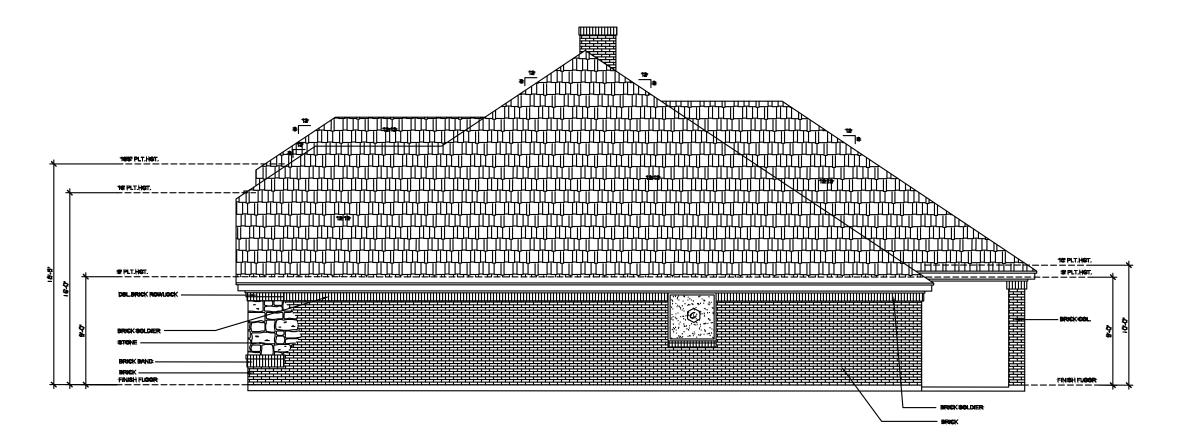
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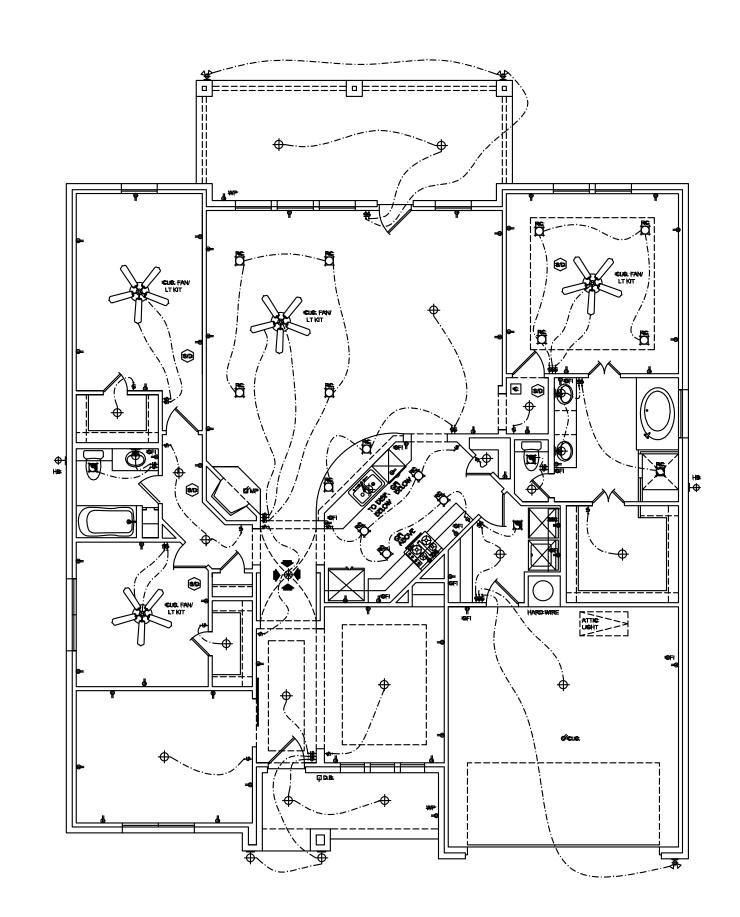
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ELEVATIONS PLAN

Date 4/28/202	Drawn By ER
Scale 1/8"=1	-0"

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OIT ASSUME LIABILITY FOR ANY DAMAGES DUE TO FERRORS, OMISSIONS, OR
ENCIES ON THESE PLANS. OWNER/BUILDER MUST COMPLY WITH LOCAL BUILDING
SINGUIS OF THESE PLANS FRUITLES THE BUYEN. TO CONSTRUCT THIS HOUSE

Project Name & Address

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ELECTRICAL PLAN

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ELECTRICAL PLAN scale: 1/8"=1'-0"

ELECTRICAL SCHEDULE

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